

TE KOHA

LOT NUMBER

38

BEDROOMS

3

BATHROOMS

2

HOUSE SIZE (m²)

125

SECTION SIZE (m²)

485

LOT LOCATION

REAR SECTION (ACCESS LEG OFF ROAD 2)

IN PARTNERSHIP WITH
KA URUORA

PROUDLY DEVELOPED BY
 **Raukawa**

TEKOHA-TOKOROA.NZ

PLANNING & ZONING		CONSTRUCTION		CLADDING		FITOUT	
Lot / DP Number	Part lot 15 DP 3320, Part lot 13&14 DP8320, Lot 7&8 DPS 23458	Foundation Type	Cupolex Ecodome system (designed to NZS3604:2011	Wall Cladding Type 1	JH Stria	Flooring Types	Carpet/Vinyl
		Stud Height	2.4m	Wall Cladding Type 2	Truwood Vertical w/b	Balustrade Type	N/A
Address	Lot 38, Tokoroa East Primary School Development Tokoroa	Typical Joinery Height	2.1m	Wall Cladding Type 3	N/A	Shower Type	Acrylic
Territorial Authority	SWDC	Typical Internal Door Height	2m	Roof Cladding	Trapezoidal Coloursteel	Water Heating	external HWC
District Plan Zone	Commercial Zone	Rebated Joinery	N/A	Fascia Type	Metal	Space Heating	Heatpump
Easements	N/a	Wall Underlay	Thermakraft WaterGate Plus	CONSULTANTS		SITE/BUILDING INFORMATION	
Relevant Consent Notices	TBC	Roof Underlay	Thermakraft Covertex 401	Topographical Survey	Envelope Engineering	Site Coverage	463m²/26.9%
Resource Consent #	RM230072	Wall Insulation	90mm R2.4 Pink Batts Classic Wall	Structural Engineer	N/a	Floor Area	125m²
Wind Zone	High (to NZS3604:2011)	Ceiling Insulation	175mm R4 Pink Batts Classic Ceiling	Geotechnical Engineer	HDGO Engineering	Minimum Floor Level (to u/s floor)	To NZBC
Corrosion Zone	B	Floor Insulation	N/a	Truss Manufacturer	ITM		
Earthquake Zone	2	Wet Area Membrane	N/a				





Proposed Dwelling - K03.1		Client: Raukawa Iwi Development Ltd.	 Print In Color		Drawing Set: WD - K03.1	All work must comply with relevant NZS & council requirements. All dimensions to be verified on site by contractor prior to commencing work, do not scale from drawings. If there are any inaccuracies with the drawings please contact designer immediately. Copyright for design & drawings retained by Prime Designs Wgtn Ltd.		
Tokoroa East Primary School Development		Job No: 24114			Drawn By: A Samson			
		Date: 16/01/2026						
admin@primedesigns.co.nz		04 528 8405	3 Jupiter Grove, Trentham, Upper Hutt		Drawing Sheet: Project Specifications		Drawing No: 102	

- NOTES:
1. ALL PUBLIC WORKS WORKS TO COMPLY WITH THE REGIONAL INFRASTRUCTURE TECHNICAL SPECIFICATIONS.
 2. CONTRACTOR TO COMPLY WITH REQUIREMENTS OF HEALTH AND SAFETY ACT 2016.
 3. CONTRACTOR TO LOCATE AND PROTECT ALL EXISTING SERVICES.
 4. CONTRACTOR TO REINSTATE ALL AFFECTED SURFACE AREAS.
 5. ALL PRIVATE WORKS TO BE COMPLETED IN ACCORDANCE WITH RELEVANT BUILDING CODE STANDARDS.
 6. ALL MANHOLES TO BE DN1050 UNLESS OTHERWISE SHOWN.
 7. ALL PUBLIC STORMWATER PIPE SIZES TO BE AS NOTED ON PLAN.
 8. PRIVATE STORMWATER CONNECTIONS TO BE DN100 uPVC SNI6 UNLESS OTHERWISE SHOWN.
 9. ALL PUBLIC WASTEWATER PIPE TO BE DN150 uPVC SNI6.
 10. PRIVATE WASTEWATER LATERALS TO BE DN100 uPVC UNLESS OTHERWISE SHOWN.
 11. ALL PRESSURE SEWER TO BE PE 100 PN 12.5

LEGEND:

	STORMWATER - EXISTING
	STORMWATER - PROPOSED PUBLIC
	STORMWATER - LATERAL
	STORMWATER - SUMP
	STORMWATER - OVERLAND FLOW DIRECTION
	STORMWATER - RAINGARDEN
	WASTEWATER - EXISTING
	WASTEWATER - PROPOSED PUBLIC (GRAVITY)
	WASTEWATER - PROPOSED PUBLIC (LPS)
	WASTEWATER - LATERAL (GRAVITY)
	WASTEWATER - LATERAL (LPS CONNECTION) WITH BOUNDARY KIT
	WASTEWATER - PEET VALVE
	WASTEWATER - FLUSHING POINT

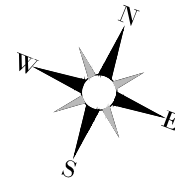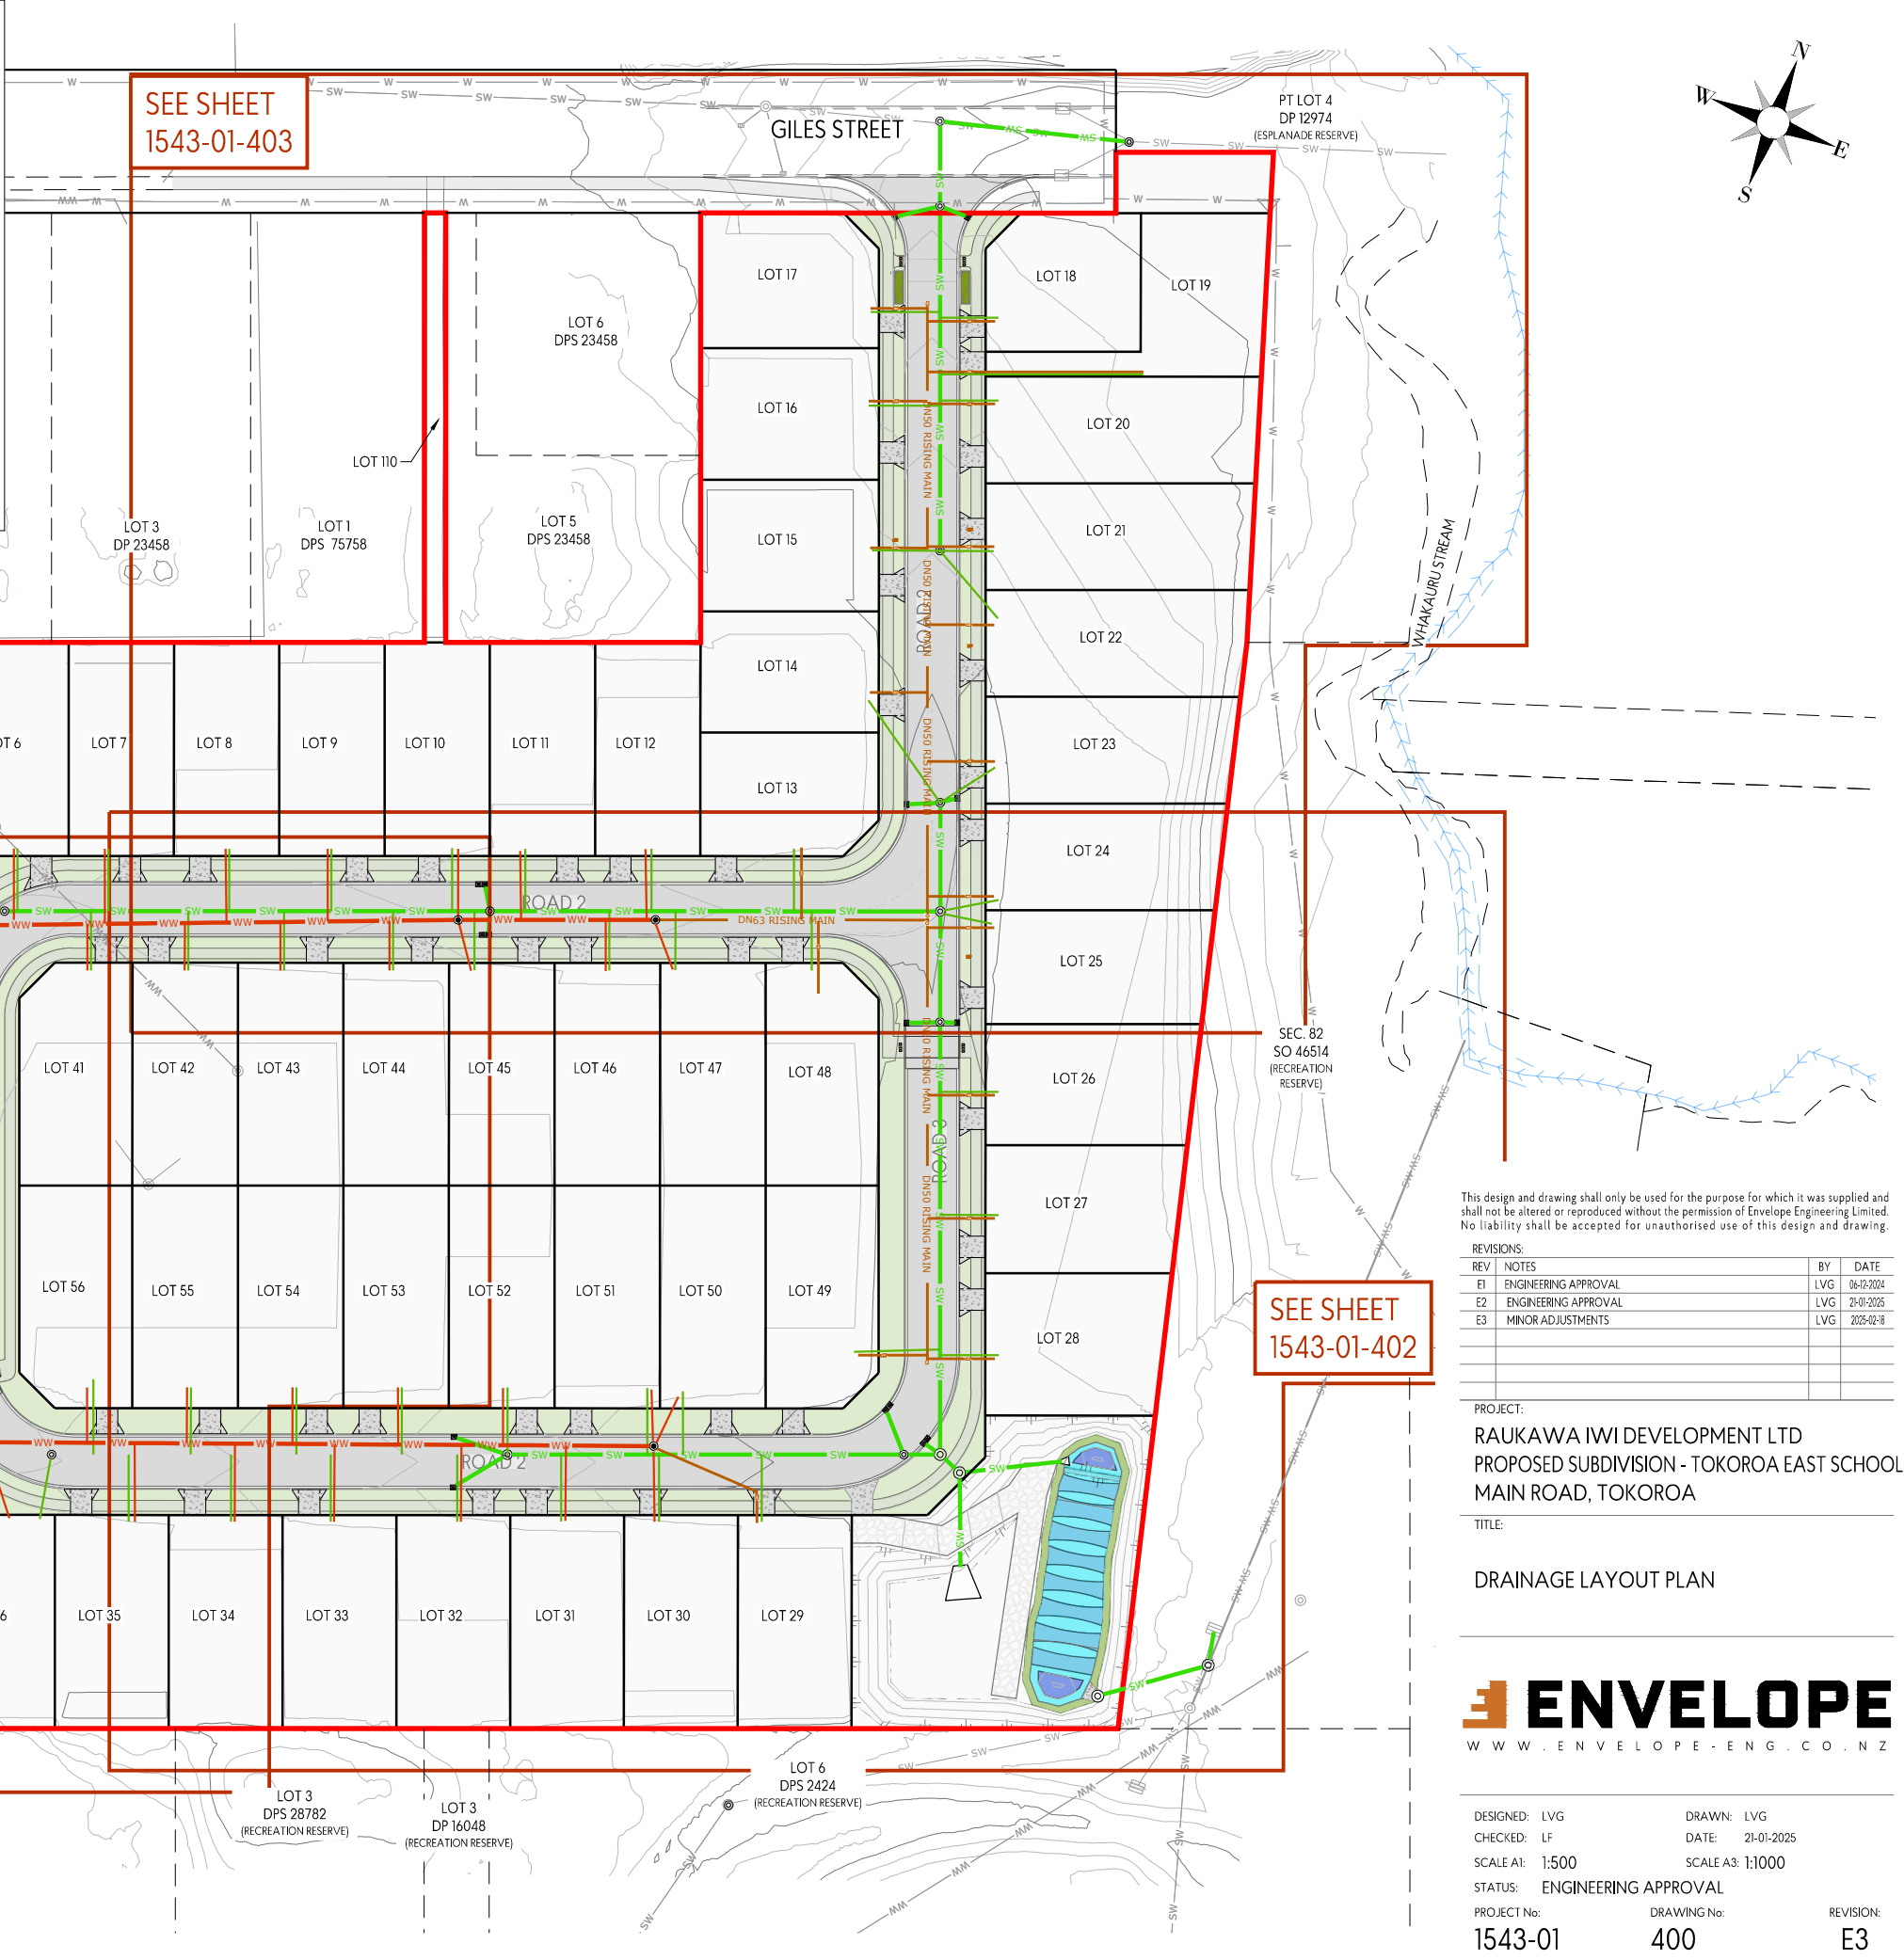

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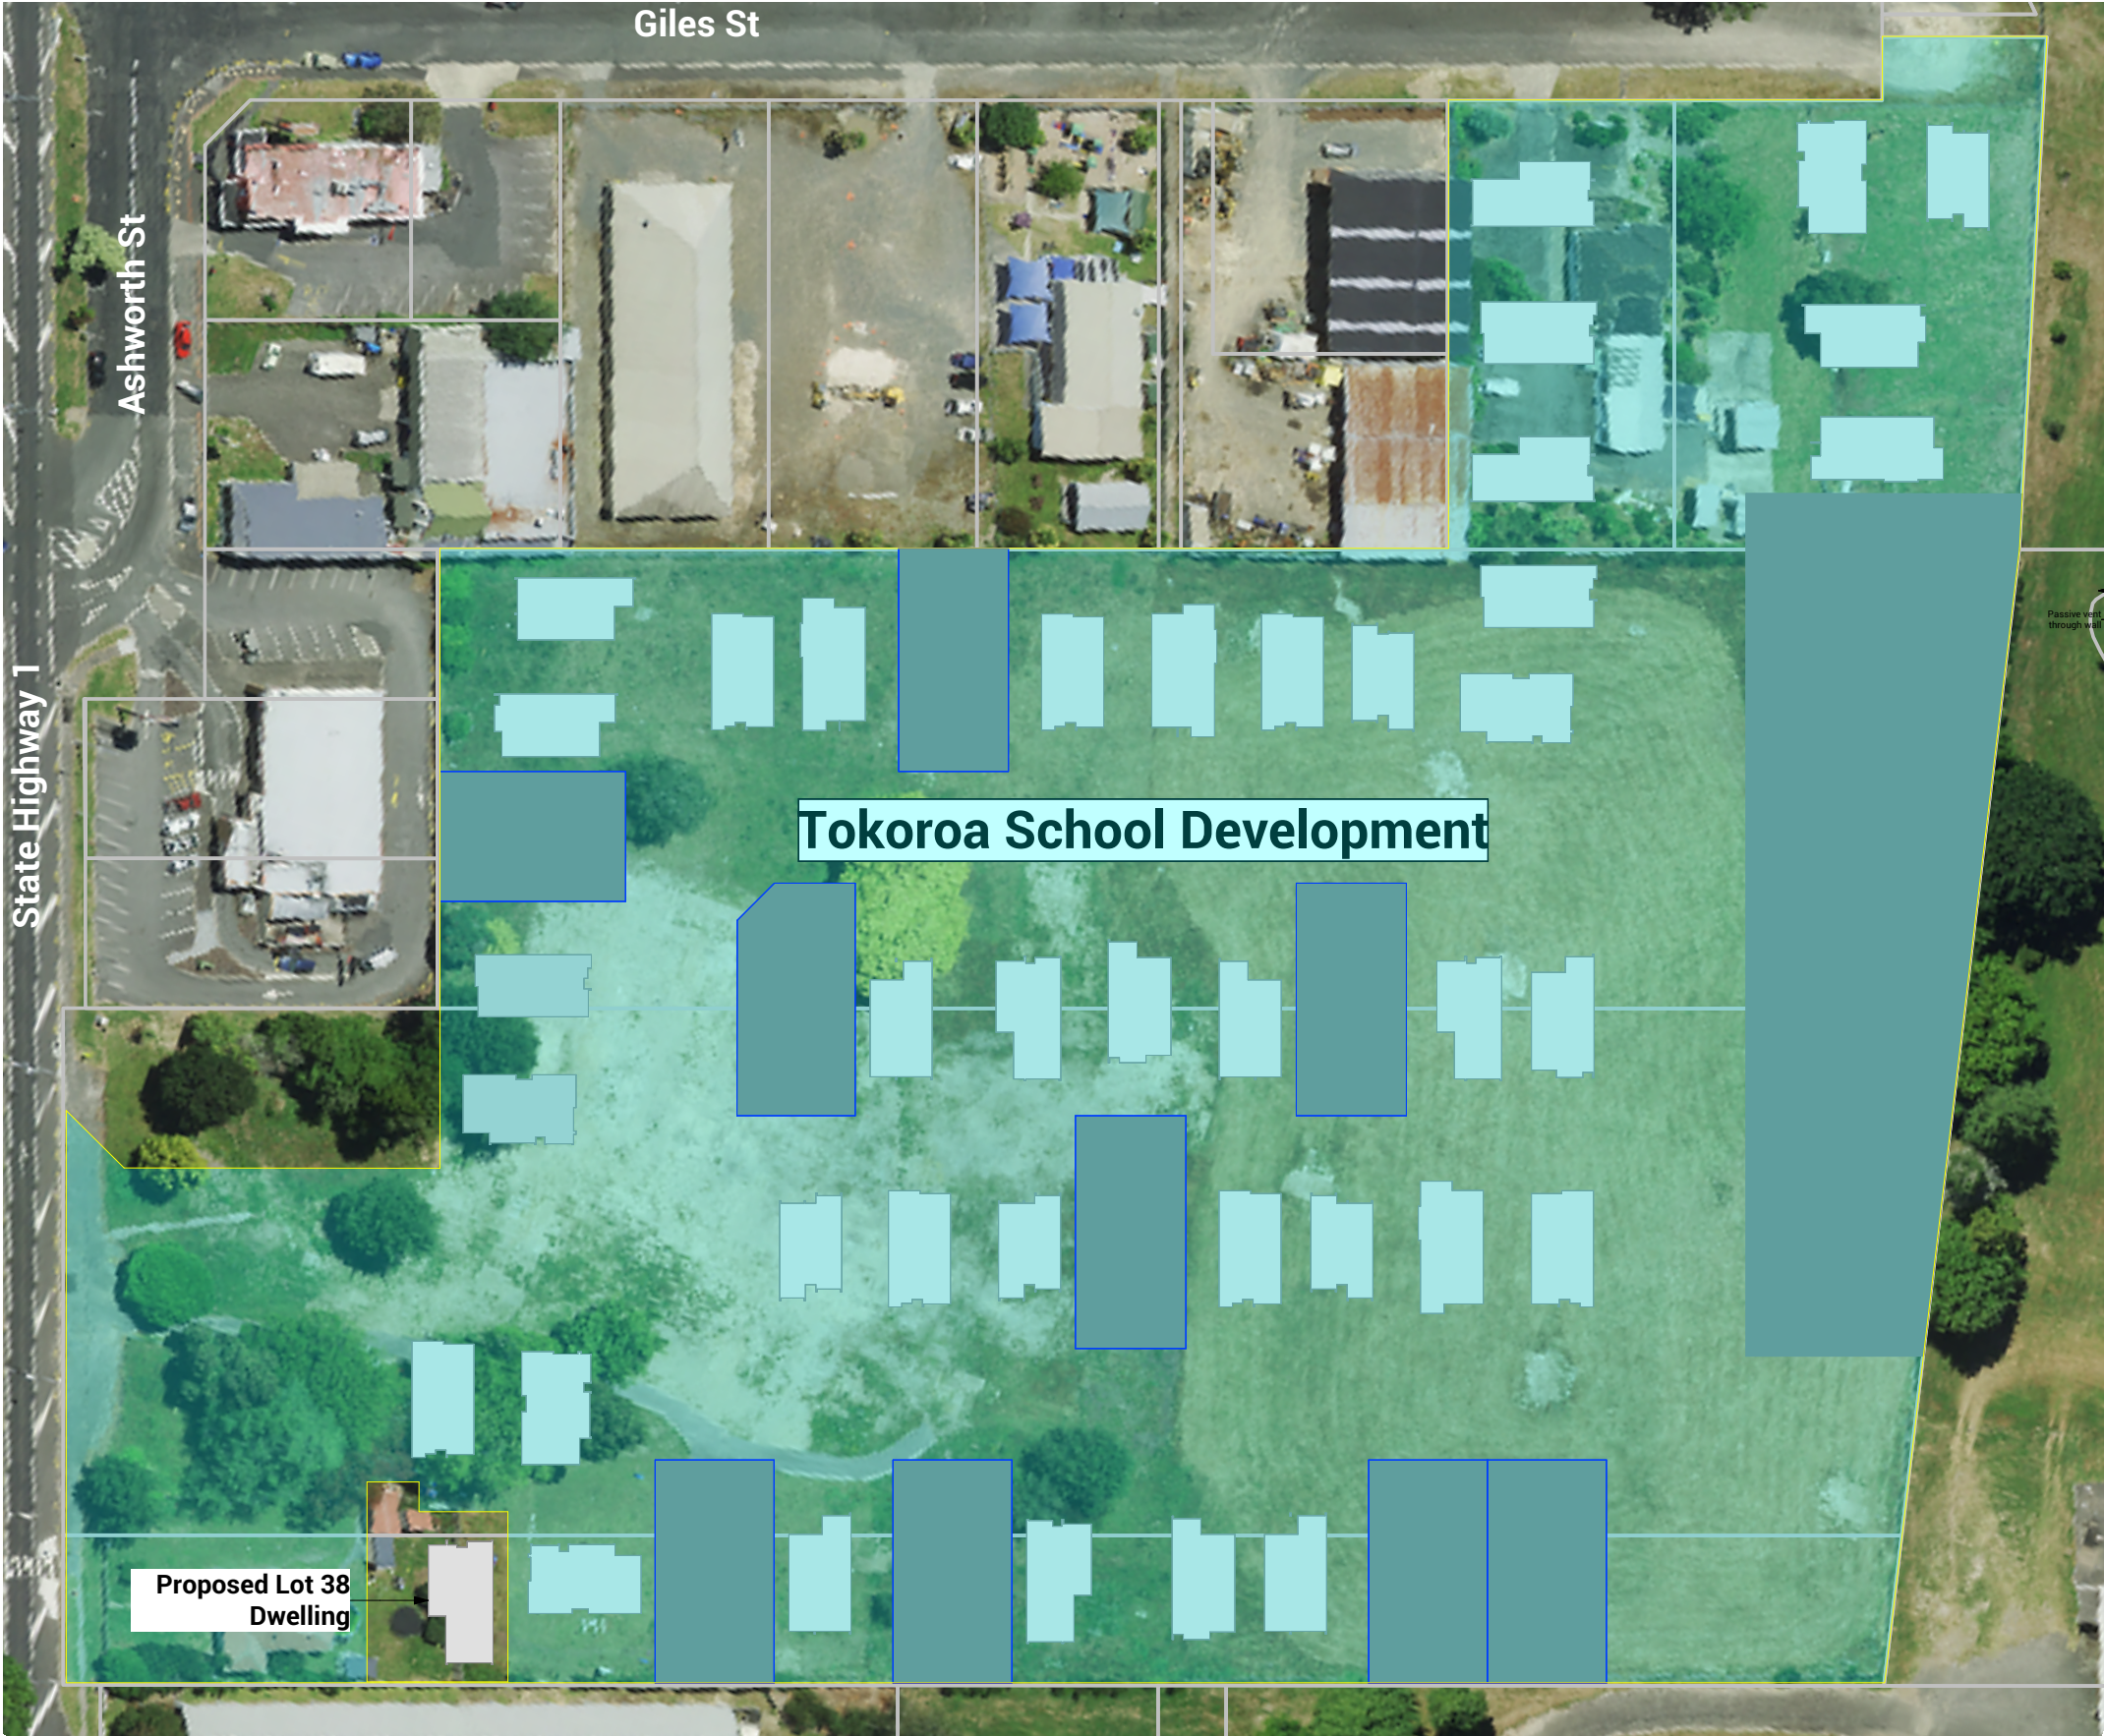
REVISIONS:			
REV	NOTES	BY	DATE
E1	ENGINEERING APPROVAL	LVG	06-12-2024
E2	ENGINEERING APPROVAL	LVG	21-01-2025
E3	MINOR ADJUSTMENTS	LVG	2025-02-18

PROJECT:
RAUKAWA IWI DEVELOPMENT LTD
PROPOSED SUBDIVISION - TOKOROA EAST SCHOOL
MAIN ROAD, TOKOROA

TITLE:
DRAINAGE LAYOUT PLAN



DESIGNED: LVG	DRAWN: LVG
CHECKED: LF	DATE: 21-01-2025
SCALE A1: 1:500	SCALE A3: 1:1000
STATUS: ENGINEERING APPROVAL	
PROJECT No: 1543-01	DRAWING No: 400
	REVISION: E3




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Lot 38 - Tokoroa East Primary School Development		Job No: 24114			Drawn By: A Samson		
		Date: 30/06/2025			Scale: 1:1000		
admin@primedesigns.co.nz		04 528 8405	3 Jupiter Grove, Trentham, Upper Hutt		Drawing Sheet: Site Location Plan	Drawing No: 104	

Legend

- JH Stria
- Truwood Vertical w/b
- Internal LBW

Natural Light and Ventilation Calculation			
	Floor Area	Light %	Ventilation %
Lounge/Kitchen	39.47m ²	4.08m ² / 10.34%	2.52m ² / 6.38%
Bedroom 1	10.89m ²	1.4m ² / 12.86%	1.19m ² / 10.93%
Bedroom 2	9.90m ²	1.4m ² / 14.14%	1.19m ² / 12.02%
Bedroom 3	9.29m ²	3.92m ² / 42.20%	1.81m ² / 19.48%

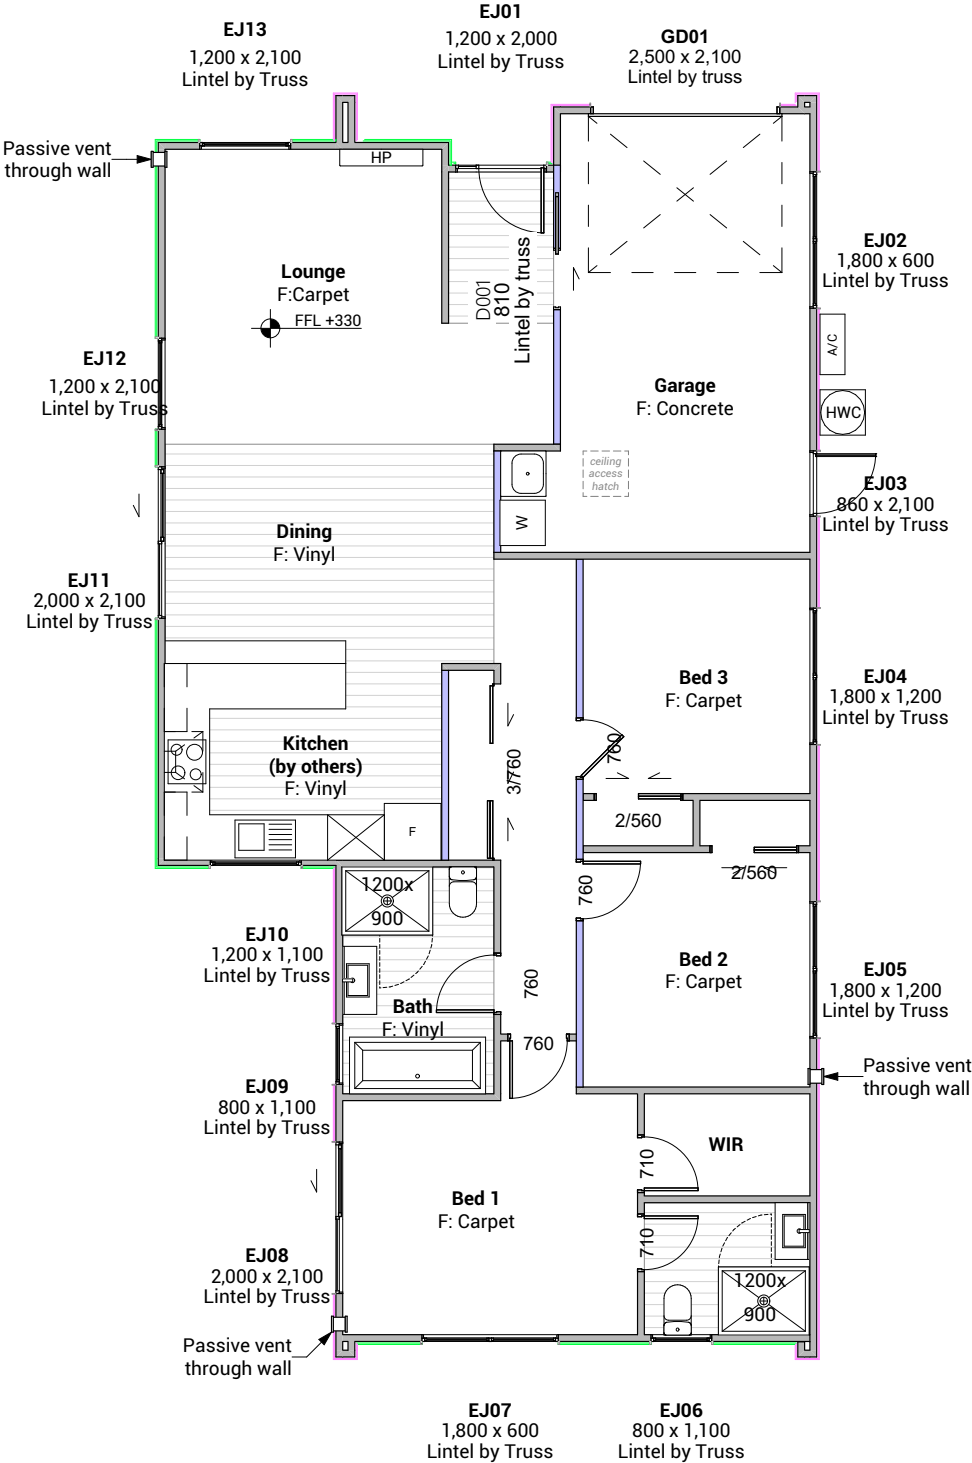

Floor Area	
Total Floor Area	125m ²

Floor Plan Notes

Walls

Wall framing general
2/90x45mm top plates to all walls. Nog for all fittings, fixtures, linings, bracing panels & trims
Wall framing height to be 2465mm finished

DPC between bottom plate and concrete slab. All external and internal loadbearing walls use Bowmac bottom plate screw bolt (M10x140) to comply with clause 7.5.12.3 and all internal non-loadbearing walls use Ramset drive pin LWU75 to comply with clause 7.5.12.4. All fixings are to be within 150mm of each end of the plate and be spaced @ 900mm crs max to comply with NZS 3604:2011 clause 7.5.12.2.

All trimming studs to comply with NZS3604:2011 clause 8.5.2.1 unless specified otherwise by pre-nailer

All window and door sizes shown on the plans refer to 'Box' size only and do not allow for packers. Pre-nailer to increase opening width accordingly

Lintels
Refer to truss manufacturers documentation for lintel sizes and fixings including lintels on internal load bearing walls.

Ground Floor wall framing
Load bearing wall framing to be 90x45mm H1.2 SG8 framing, studs @ 600mm crs to NZS3604:2011
Non-Load bearing wall framing to be 90x45mm H1.2 SG8 framing, studs @ 600mm crs to NZS3604:2011
90x45 dwangs spaced at 800mm crs. NZS3604:2011 (Check cladding requirements for dwang spacing).

Fixings

Zone B & C fixings and fastenings
Structural fixings except fabricated brackets in a Sheltered environment to be - Hot-dipped galvanized steel
Structural fixings except fabricated brackets in an Exposed environment to be - Type 304 stainless steel
Structural fixing within 600mm of the ground to be - Type 304 stainless steel
All fixings to be suitable for exposure zone C as outlined in NZS3604:2011 section 4.4 "steel fixings and fastenings"

Fixings and fastenings all Zones
Nail plates, wire dogs & bolts in roof spaces and closed environments to be Continuously coated galvanized steel or Hot-dipped galvanized steel

Underlays

Thermakraft Wall underlay
Thermakraft Watergate Plus wall underlay installed to wall framing using 6-8mm staples or 20mm large head galvanized clouts at 300mm crs horizontally and vertically. 150mm min overlap at joins, all vertical laps must be made over studs. Installed to manufacturers specification. Additionally, install 25mm wide Thermastrap horizontally at 300mm crs
Thermakraft Aluband
Thermakraft Aluband flashing tape to be installed at openings as per manufacturer's installation requirements, unless noted on joinery details otherwise.

Insulation

Wall insulation
90mm thick R2.4 Pink Batts Classic wall insulation to all external walls and internal walls between garage and habitable space. No insulation to

garage external walls.
Ceiling insulation
195mm thick R4 Pink batts Ultra ceiling insulation, ensure a 25mm gap min. between insulation and roof underlay.

Wall Claddings

James Hardie horizontal Stria cladding over 20mm cavity

Horizontal James Hardie Stria wide panel cladding over 45x18mm H3.1 timber cavity battens (Cladding weight:16kg/m2). Refer to manufacturer's information & Details for fixing and waterproofing requirements. Dwangs @ 800ctrs.

Vertical Truwood Weatherboards over 20mm cavity

Client selected vertical Cedarscreen Truwood weatherboards fixed over cavity battens over wall underlay (Cladding weight 8.75kg/m2), Refer to details and manufacturer's information for fixing and waterproofing requirements. Dwangs @ 480ctrs.

Acoustic Requirement
Minimum acoustic insulation as per NDY Noise Intrusion Assessment to meet the requirements of Resource Consent Condition 16.

Non-glazed walls to be 90mm studs with 90mm insulation and 10mm plasterboard, minimum cladding density 7.5kg/m2.
Glazed areas to be 4mm glass/8mm air gap/4mm glass minimum.

Linings

10mm GIB plasterboard wall lining
Generally, line with 10mm GIB Standard plasterboard (Aqualine to wet areas, installed as per GIB Wet Area Systems specifications and installation manual 2021) stopped for level 4 paint finish (unless otherwise indicated). Refer also specific fitout dwgs & bracing schedule for specific wall linings & requirements.

13mm GIB board ceiling lining (Rondo batten)
Generally, line with 13mm Gib board ceiling with Rondo 310 ceiling battens and 311 clips at 600 crs fixed to trusses and/or joists. Gib Aqualine to wet areas. Stopped for level 4 finish.

Wall linings adjacent to appliances
CL1.6 G3, Wall linings adjacent to appliances and facilities shall have surfaces that can be easily maintained in a hygienic condition and comply with. Stainless steel, decorative high-pressure laminate, tiles, wallboards with painted or applied impervious coatings or films, are all suitable materials for these surfaces.

Floor Coverings

Slip resistance
Minimum slip resistance co-efficient for level surface between 0.25 and 0.50 acceptable in accordance with NZBC:D1/AS1 Access.

Vinyl Plank Flooring - Avvio
Vinyl plank to be installed over vinyl adhesive in areas noted on floor plan. Where installed in a wet area (including laundry and kitchen), install as per attached manufacturer's documentation and E3/AS1 alternative solution documentation.

Interior Fit-out

Internal doors
All internal door leaf widths as noted on floor plan, all heights 1980mm unless otherwise noted

Architraves
Architraves to be installed to all internal doors and windows

Passive Ventilation
Passive ventilation to be provided to habitable spaces (living area and bedrooms) in the form of Manrose Puro through wall passive vent kit (non filtered). 3000mm2 effective aerodynamic area per vent. Install in locations shown on floor plan.

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Lot 38 - Tokoroa East Primary School Development Job No: 24114 Date: 30/06/2025

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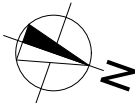
Drawing Set: WD - K03.1

Drawn By: A Samson






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Drawing Sheet: Floor Plan


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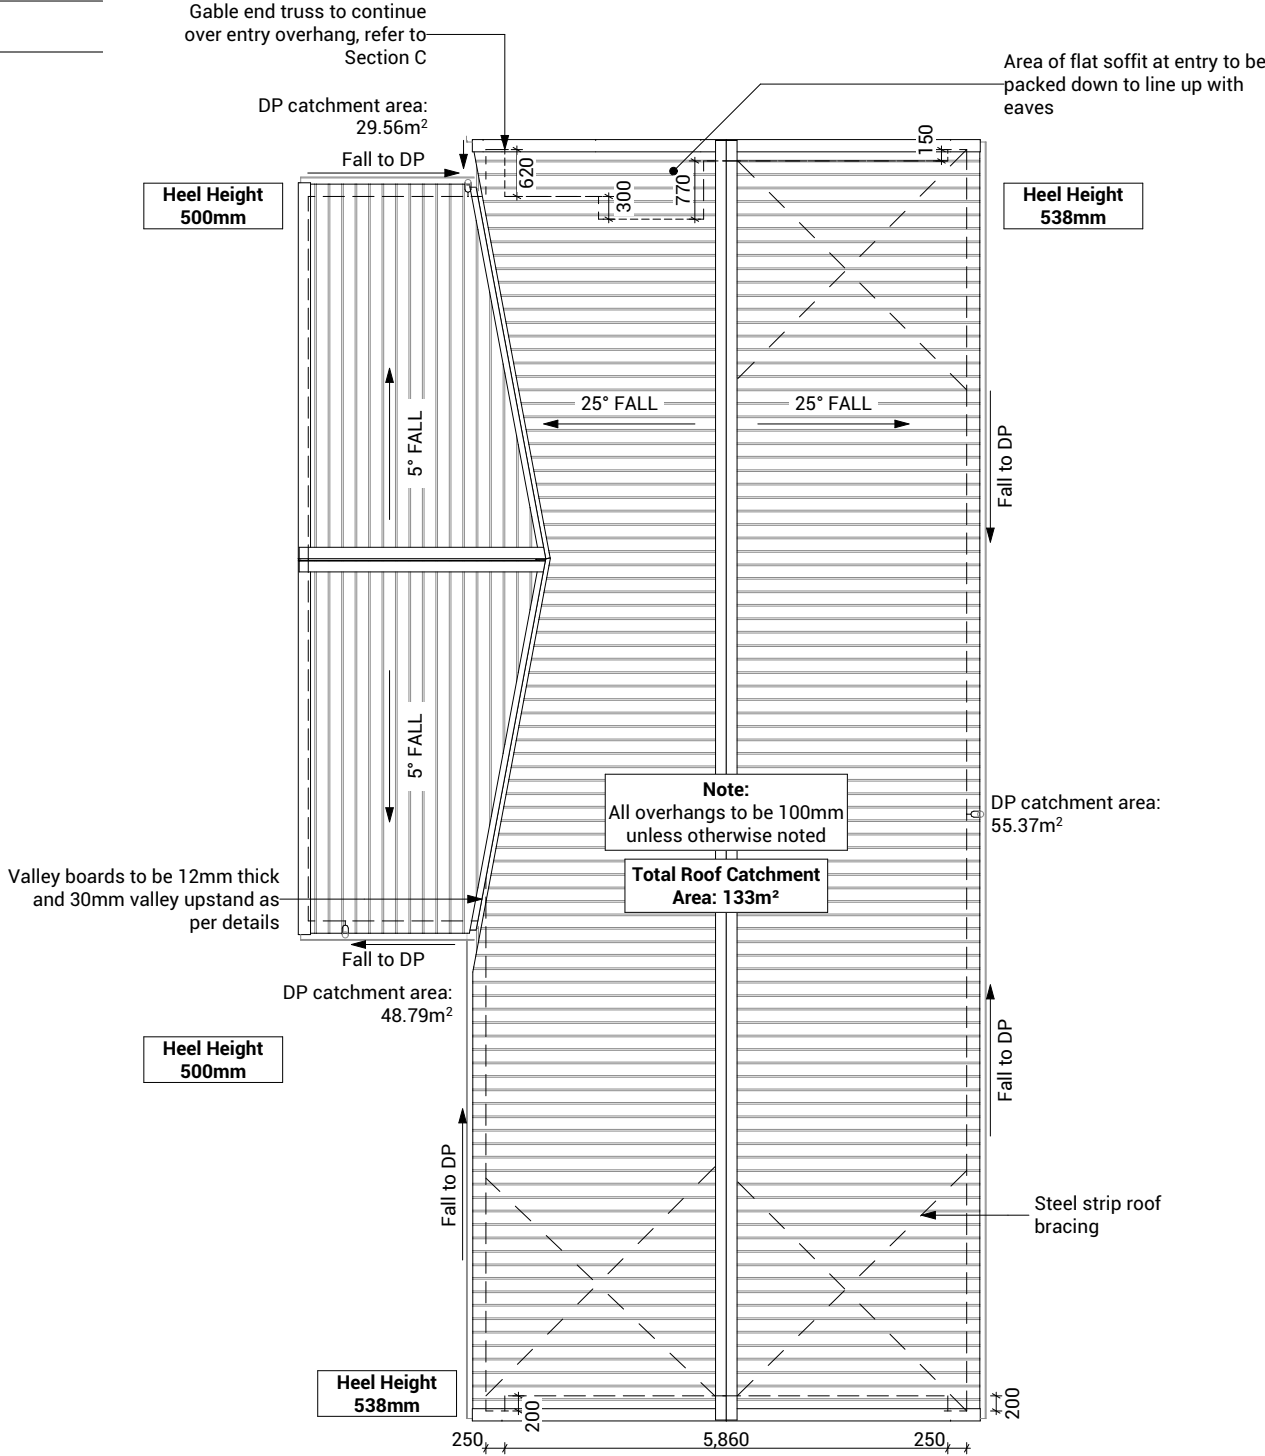
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admin@primedesigns.co.nz		Date:	30/06/2025				Scale:	1:100					
04 528 8405		3 Jupiter Grove, Trentham, Upper Hutt		Drawing Sheet:		Dimension Plan		Drawing No:		109			



Max Capacity Roof Area	18.87m²
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Conditions and assumptions for valleys:

1. Mannings n assumed to be 0.014 to represent long term friction conditions
2. Minimum height of Type A valley returns to be 16 mm
3. Minimum freeboard of 20mm mm for valleys below 8°
4. Minimum freeboard of 15mm for valleys 8° and steeper

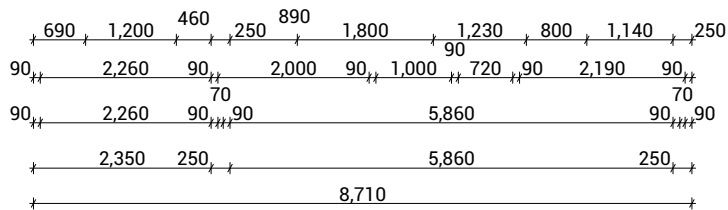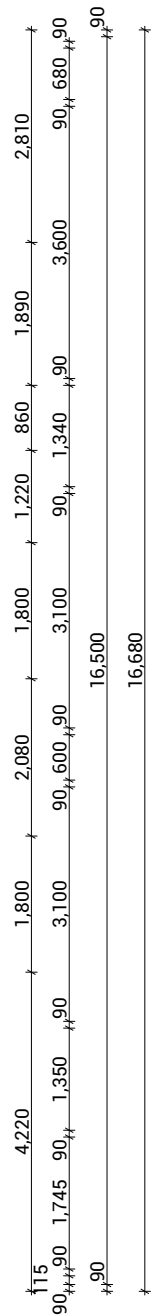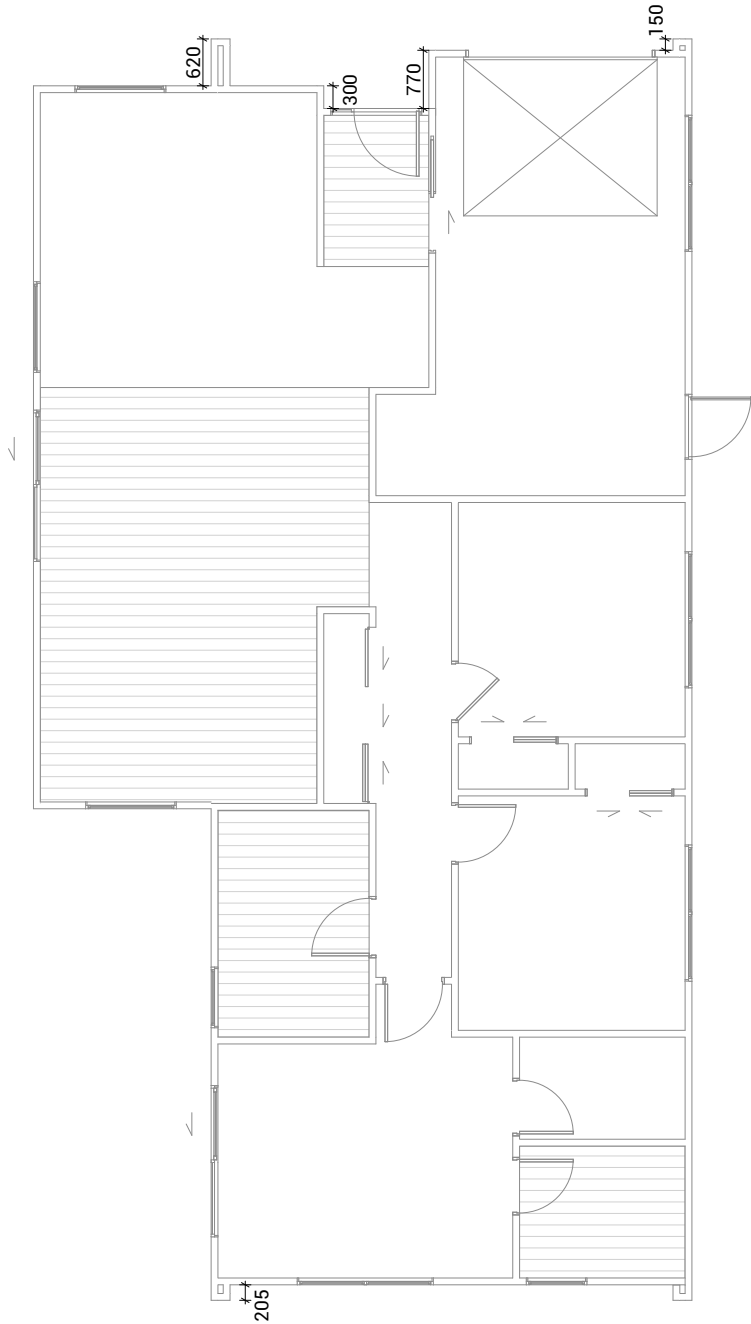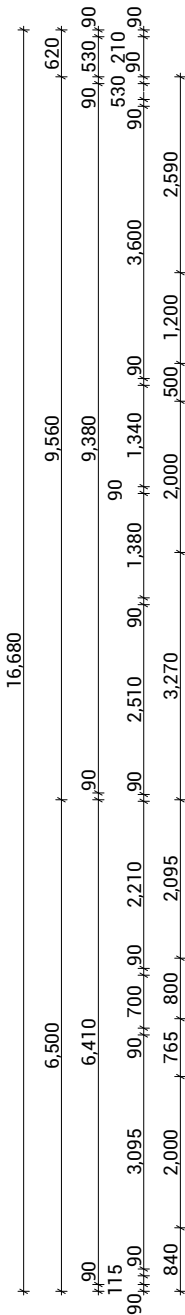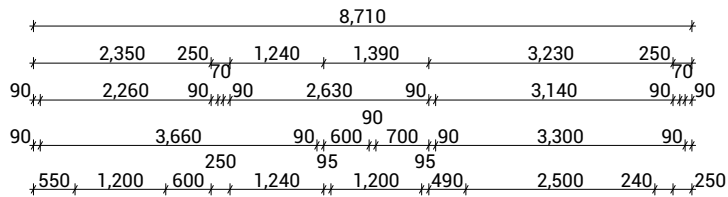

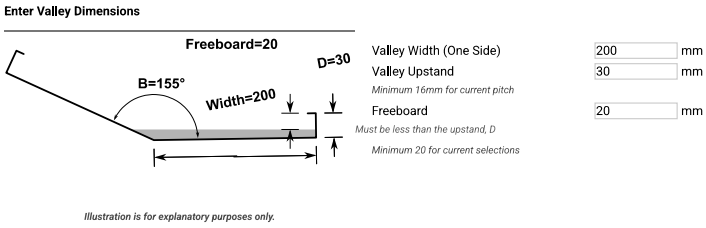Roof Plan Notes

General Notes

Roof framing general

Trusses designed by truss manufacturer, refer to manufacturer's documentation.

All enclosed framing to be H1.2 SG8 unless otherwise noted. Framing to comply with NZS3604:2011

Client selected metal fascia.

Roof bracing to comply with NZS3604:2011 section 10.4

Zone B & C fixings and fastenings

Structural fixings except fabricated brackets in a Sheltered environment to be - Hot-dipped galvanized steel

Structural fixings except fabricated brackets in an Exposed environment to be - Type 304 stainless steel

All fixings be suitable for exposure zone C as outlined in NZS3604:2011 section 4.4 "steel fixings and fastenings"

Fixings and fastenings all Zones

Nail plates, wire dogs & bolts in roof spaces and closed environments to be continuously coated galvanized steel or Hot-dipped galvanized steel

Continuous spouting rainwater system

Continuous spouting rainwater system, spouting to have 4880mm² cross sectional area, DN80 downpipes unless otherwise noted.

Roof Bracing

Steel strip roof bracing

Diagonally opposing pair of continuous steel strips at a 45° each having a capacity of 4.0kN in tension, fixed to each top chord or rafter that is intersected and to the top plate

Bottom Cord Restraints for GIB Rondo clip system

When GIB Rondo clip system is installed additional 90x35 SG8 battens @ 1800ctrs max as bottom cord restraints required.

Underlay

Roof underlay

Thermakraft 401 synthetic self-supporting roof underlay run vertically over purlins & horizontally on roof pitches less than 10 degrees. Fix using stainless steel 8-12mm staples or 20mm flat head clouts at 300mm crs. 150mm min cover over vertical and horizontal joints. Refer to manufacturer's information.

Roof Cladding

Trapezoidal roof cladding on purlins

0.55mm BMT trapezoidal profile Colorsteel Maxam roof cladding on purlins over roof underlay. Roofing profile to have a minimum crest height of 19mm and a maximum of 210mm between crests.

Purlins

70x45 Purlins (up to VH)

70x45mm H1.2 SG8 purlins @ 900mm crs regular spacing & 600mm crs end spacing, fixed to trusses with 1/10g 80mm long self-drilling screw or alternative 2.4kN fixing.

Soffit Lining

4.5mm HardieFlex soffit lining

4.5mm James Hardie HardieFlex soffit lining fixed to 90x45mm H1.2 soffit framing using 40 x 2.8mm HardieFlex nails at 200mm crs. Soffits jointed with proprietary uPVC jointers.

Proposed Dwelling - K03.1

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Lot 38 - Tokoroa East Primary
School Development

Job No: 24114

Date: 30/06/2025

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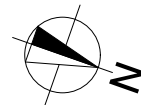
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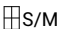







Drawing Sheet: Roof Plan


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Drawing No: 110



Electrical Legend

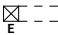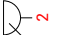-  S/M
- Smart Meter
-  G
- Garage door motor
-  S
- Smoke detector
-  E
- Extractor fan
-  2
- Power point
-  2
- Recessed downlight
-  1
- Light switch
-  2
- Two way light switch

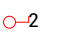

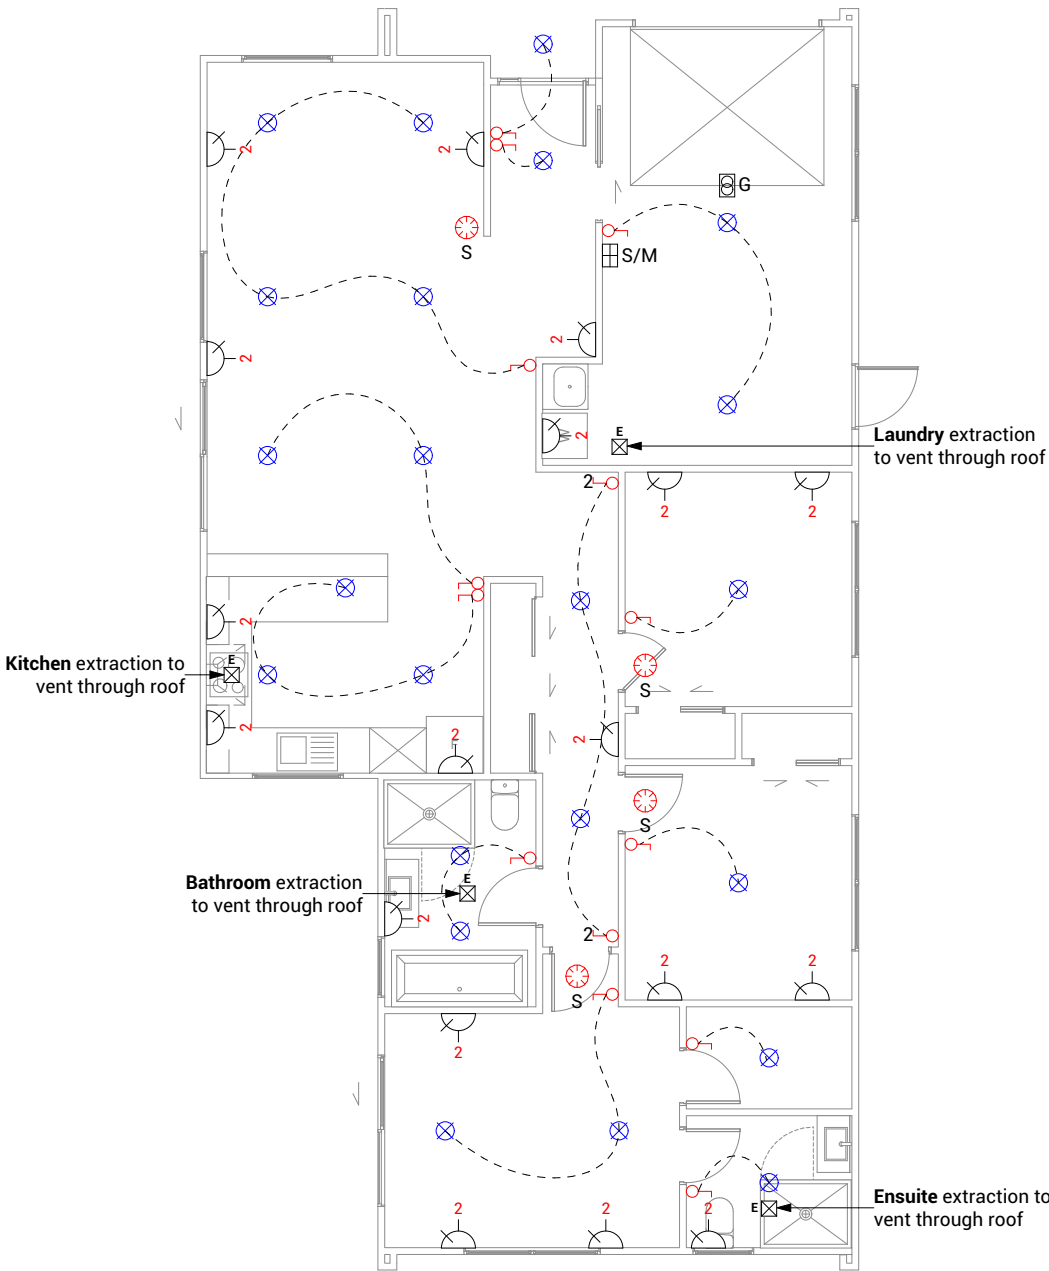Electrical Notes

General electrical notes
Ensure all habitable rooms are fitted with a minimum of one light fixture. All habitable internal spaces are to have a minimum illuminance of 20 lux or a minimal total wattage required per m2 of floor area as shown in G8/AS1, Table 1. Lights in the stairwell to provide 100lux at tread level or a total wattage per m2 of floor plan area as shown in D1/AS1 table8,

All electrical works to be installed to comply with NZBC G9/AS1, AS/NZS 3000:2018, AS/NZS 3008.1.2:2017, AS/NZS 5000.2:2006

Recessed downlights
Downlights to be CA135, CA180, IC, or IC-F to comply with AS/NZS 60598.2.2 Amendment A

Smoke detectors
Smoke detectors to be installed to comply with NZBC F7/AS1, C/AS1, NZS 4514:2021 and be located on or near the ceiling, in all bedrooms, living spaces, hallways and landings within the building. Where the kitchen is separated from the living space and hallways by doors that can be closed a heat alarm shall be located in the kitchen. There shall be at least one smoke level on each level. Where more than one smoke alarm is needed to meet the requirements, these alarms shall be interconnected as per NZS 4514:2021 clause 2.5. Smoke detectors to meet at least one of the following standards: UL 217, CAN/ULC S531, BS EN 14604, ISO 12239 or AS 3786

Mechanical ventilation
Extractor fans to be Manrose XF150 or similar, vent through roof as per manufacturer's installation instructions. Rangehood to be ducted and vented up and through roof. Dryer to be vented seperately as per NZBC G4.

Proposed Dwelling - K03.1

Client: Raukawa Iwi Development Ltd.

Lot 38 - Tokoroa East Primary
School Development

Job No: 24114

Date: 30/06/2025

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Print In Color



Drawing Set: WD - K03.1


Drawn By: A Samson

Scale: 1:100





Drawing Sheet: Electrical Plan

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Drawing No: 114

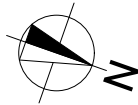

BUILDING ENVELOPE RISK MATRIX		
All Elevations		
Risk Factor	Risk Severity	Risk Score
Wind zone (per NZS 3604)	High risk	1
Number of storeys	Low risk	0
Roof/wall intersection design	High risk	3
Eaves width	Very high risk	5
Envelope complexity	Medium risk	1
Deck design	Low risk	0
Total Risk Score:		10

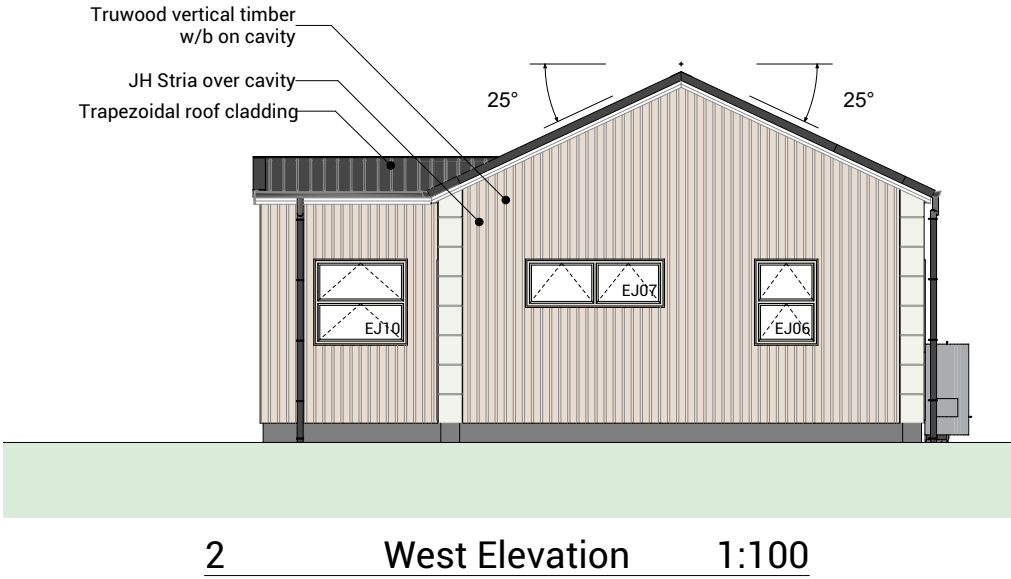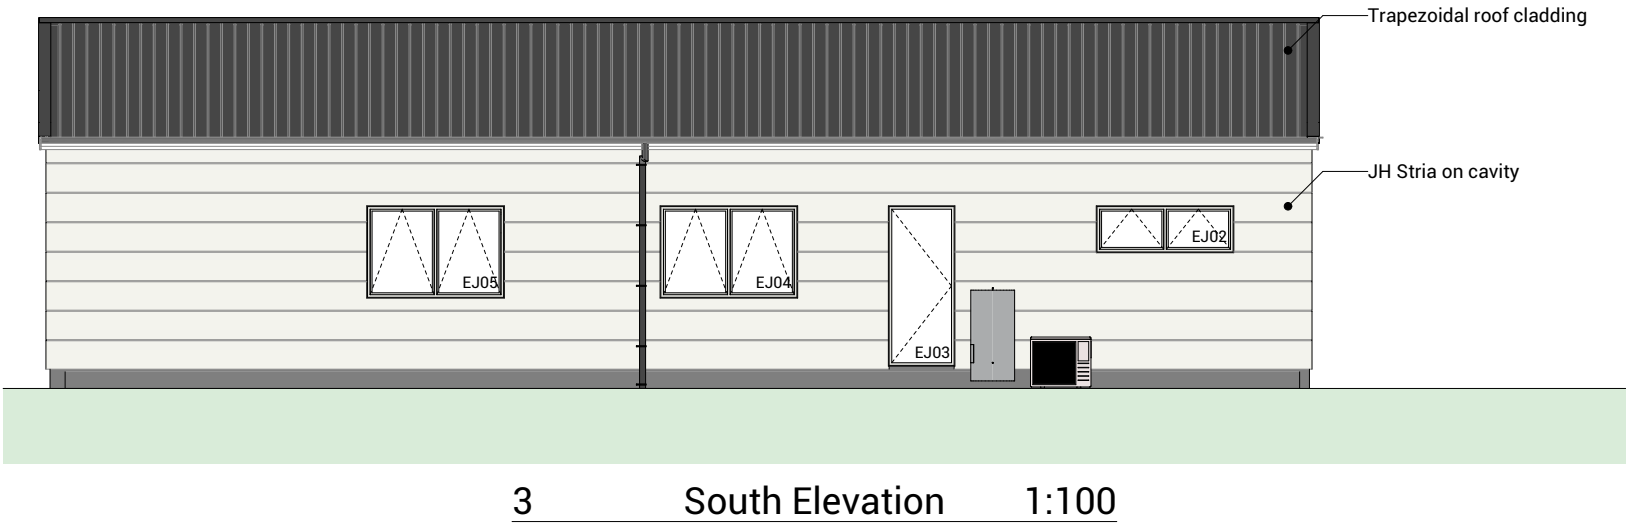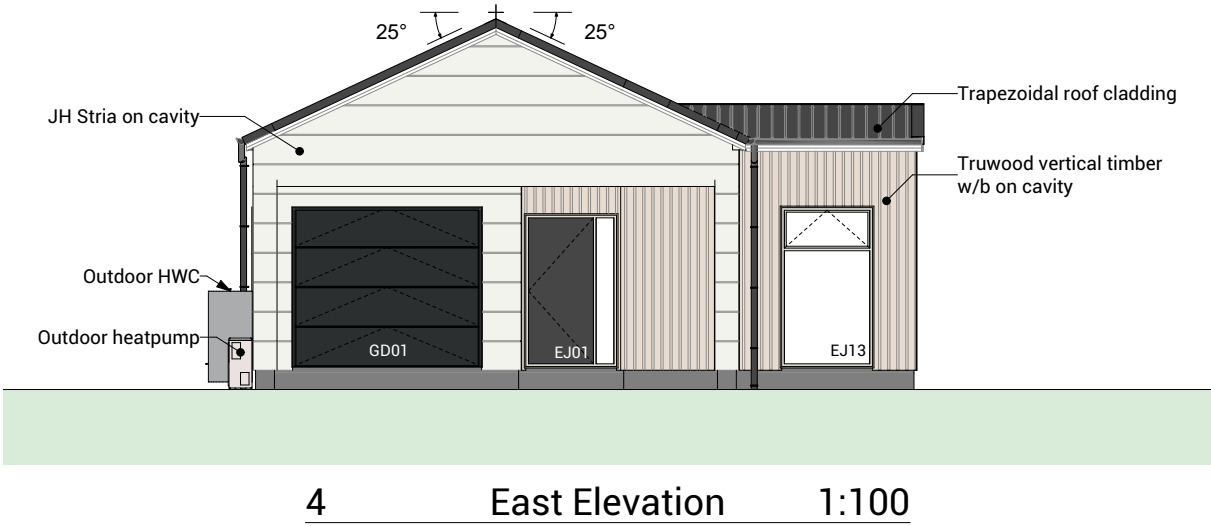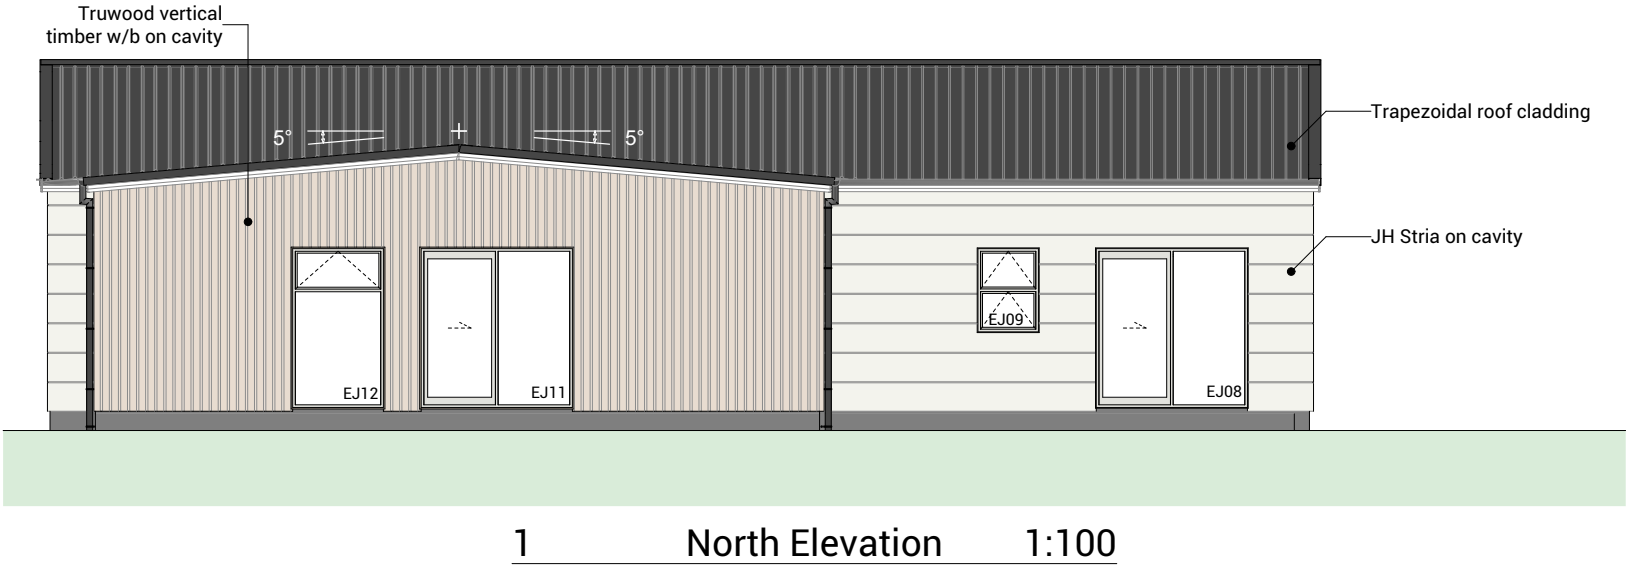

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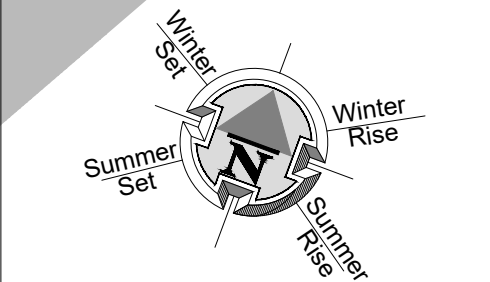
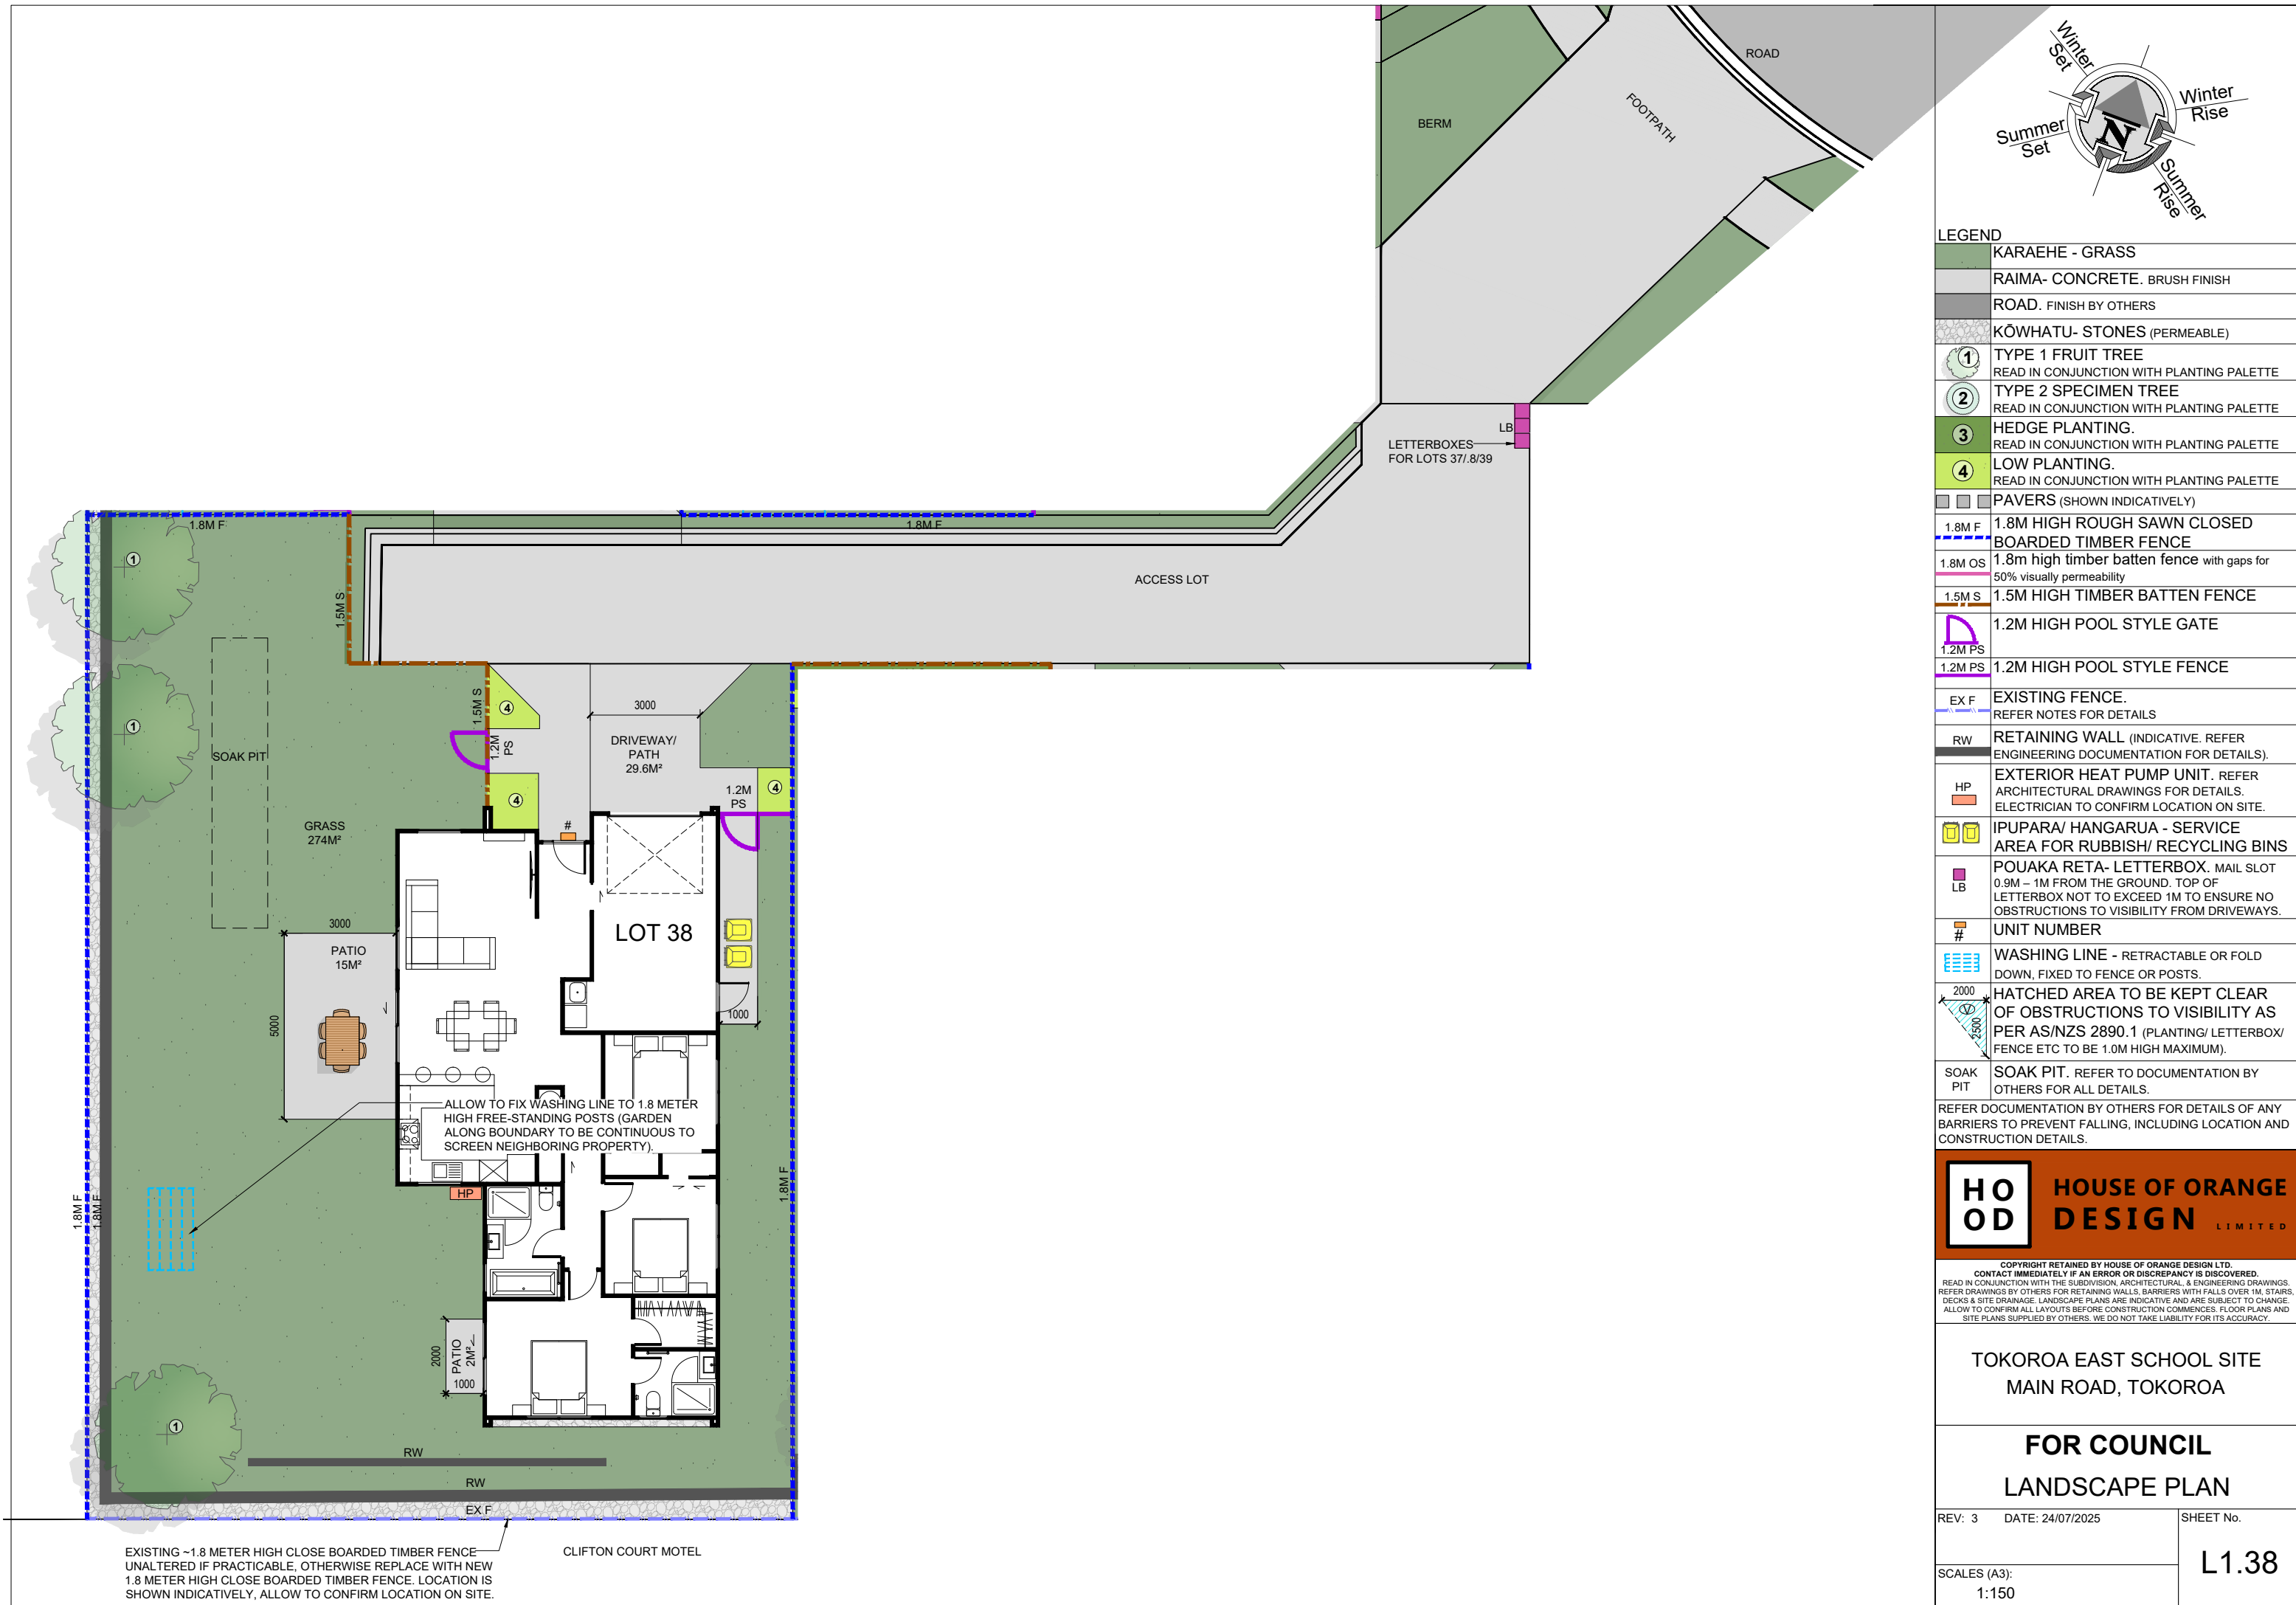
Drawn By: A Samson

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Drawing Sheet: Elevations

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Drawing No: 301



LEGEND	
	KARAEHE - GRASS
	RAIMA- CONCRETE. BRUSH FINISH
	ROAD. FINISH BY OTHERS
	KŌWHATU- STONES (PERMEABLE)
	TYPE 1 FRUIT TREE READ IN CONJUNCTION WITH PLANTING PALETTE
	TYPE 2 SPECIMEN TREE READ IN CONJUNCTION WITH PLANTING PALETTE
	HEDGE PLANTING. READ IN CONJUNCTION WITH PLANTING PALETTE
	LOW PLANTING. READ IN CONJUNCTION WITH PLANTING PALETTE
	PAVERS (SHOWN INDICATIVELY)
	1.8M HIGH ROUGH SAWN CLOSED BOARDED TIMBER FENCE
	1.8m high timber batten fence with gaps for 50% visually permeability
	1.5M HIGH TIMBER BATTEN FENCE
	1.2M HIGH POOL STYLE GATE
	1.2M HIGH POOL STYLE FENCE
	EXISTING FENCE. REFER NOTES FOR DETAILS
	RETAINING WALL (INDICATIVE. REFER ENGINEERING DOCUMENTATION FOR DETAILS).
	EXTERIOR HEAT PUMP UNIT. REFER ARCHITECTURAL DRAWINGS FOR DETAILS. ELECTRICIAN TO CONFIRM LOCATION ON SITE.
	IPUPARA/ HANGARUA - SERVICE AREA FOR RUBBISH/ RECYCLING BINS
	POUAKA RETA- LETTERBOX. MAIL SLOT 0.9M – 1M FROM THE GROUND. TOP OF LETTERBOX NOT TO EXCEED 1M TO ENSURE NO OBSTRUCTIONS TO VISIBILITY FROM DRIVEWAYS.
	UNIT NUMBER
	WASHING LINE - RETRACTABLE OR FOLD DOWN, FIXED TO FENCE OR POSTS.
	HATCHED AREA TO BE KEPT CLEAR OF OBSTRUCTIONS TO VISIBILITY AS PER AS/NZS 2890.1 (PLANTING/ LETTERBOX/ FENCE ETC TO BE 1.0M HIGH MAXIMUM).
	SOAK PIT. REFER TO DOCUMENTATION BY OTHERS FOR ALL DETAILS.
REFER DOCUMENTATION BY OTHERS FOR DETAILS OF ANY BARRIERS TO PREVENT FALLING, INCLUDING LOCATION AND CONSTRUCTION DETAILS.	

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CONTACT IMMEDIATELY IF AN ERROR OR DISCREPANCY IS DISCOVERED.
READ IN CONJUNCTION WITH THE SUBDIVISION, ARCHITECTURAL & ENGINEERING DRAWINGS.
REFER DRAWINGS BY OTHERS FOR RETAINING WALLS, BARRIERS WITH FALLS OVER 1M, STAIRS, DECKS & SITE DRAINAGE. LANDSCAPE PLANS ARE INDICATIVE AND ARE SUBJECT TO CHANGE.
ALLOW TO CONFIRM ALL LAYOUTS BEFORE CONSTRUCTION COMMENCES. FLOOR PLANS AND SITE PLANS SUPPLIED BY OTHERS. WE DO NOT TAKE LIABILITY FOR ITS ACCURACY.

TOKOROA EAST SCHOOL SITE
MAIN ROAD, TOKOROA

FOR COUNCIL
LANDSCAPE PLAN

REV: 3	DATE: 24/07/2025	SHEET No.
SCALES (A3): 1:150		L1.38

EXISTING ~1.8 METER HIGH CLOSE BOARDED TIMBER FENCE— UNALTERED IF PRACTICABLE, OTHERWISE REPLACE WITH NEW 1.8 METER HIGH CLOSE BOARDED TIMBER FENCE. LOCATION IS SHOWN INDICATIVELY, ALLOW TO CONFIRM LOCATION ON SITE.

CLIFTON COURT MOTEL